

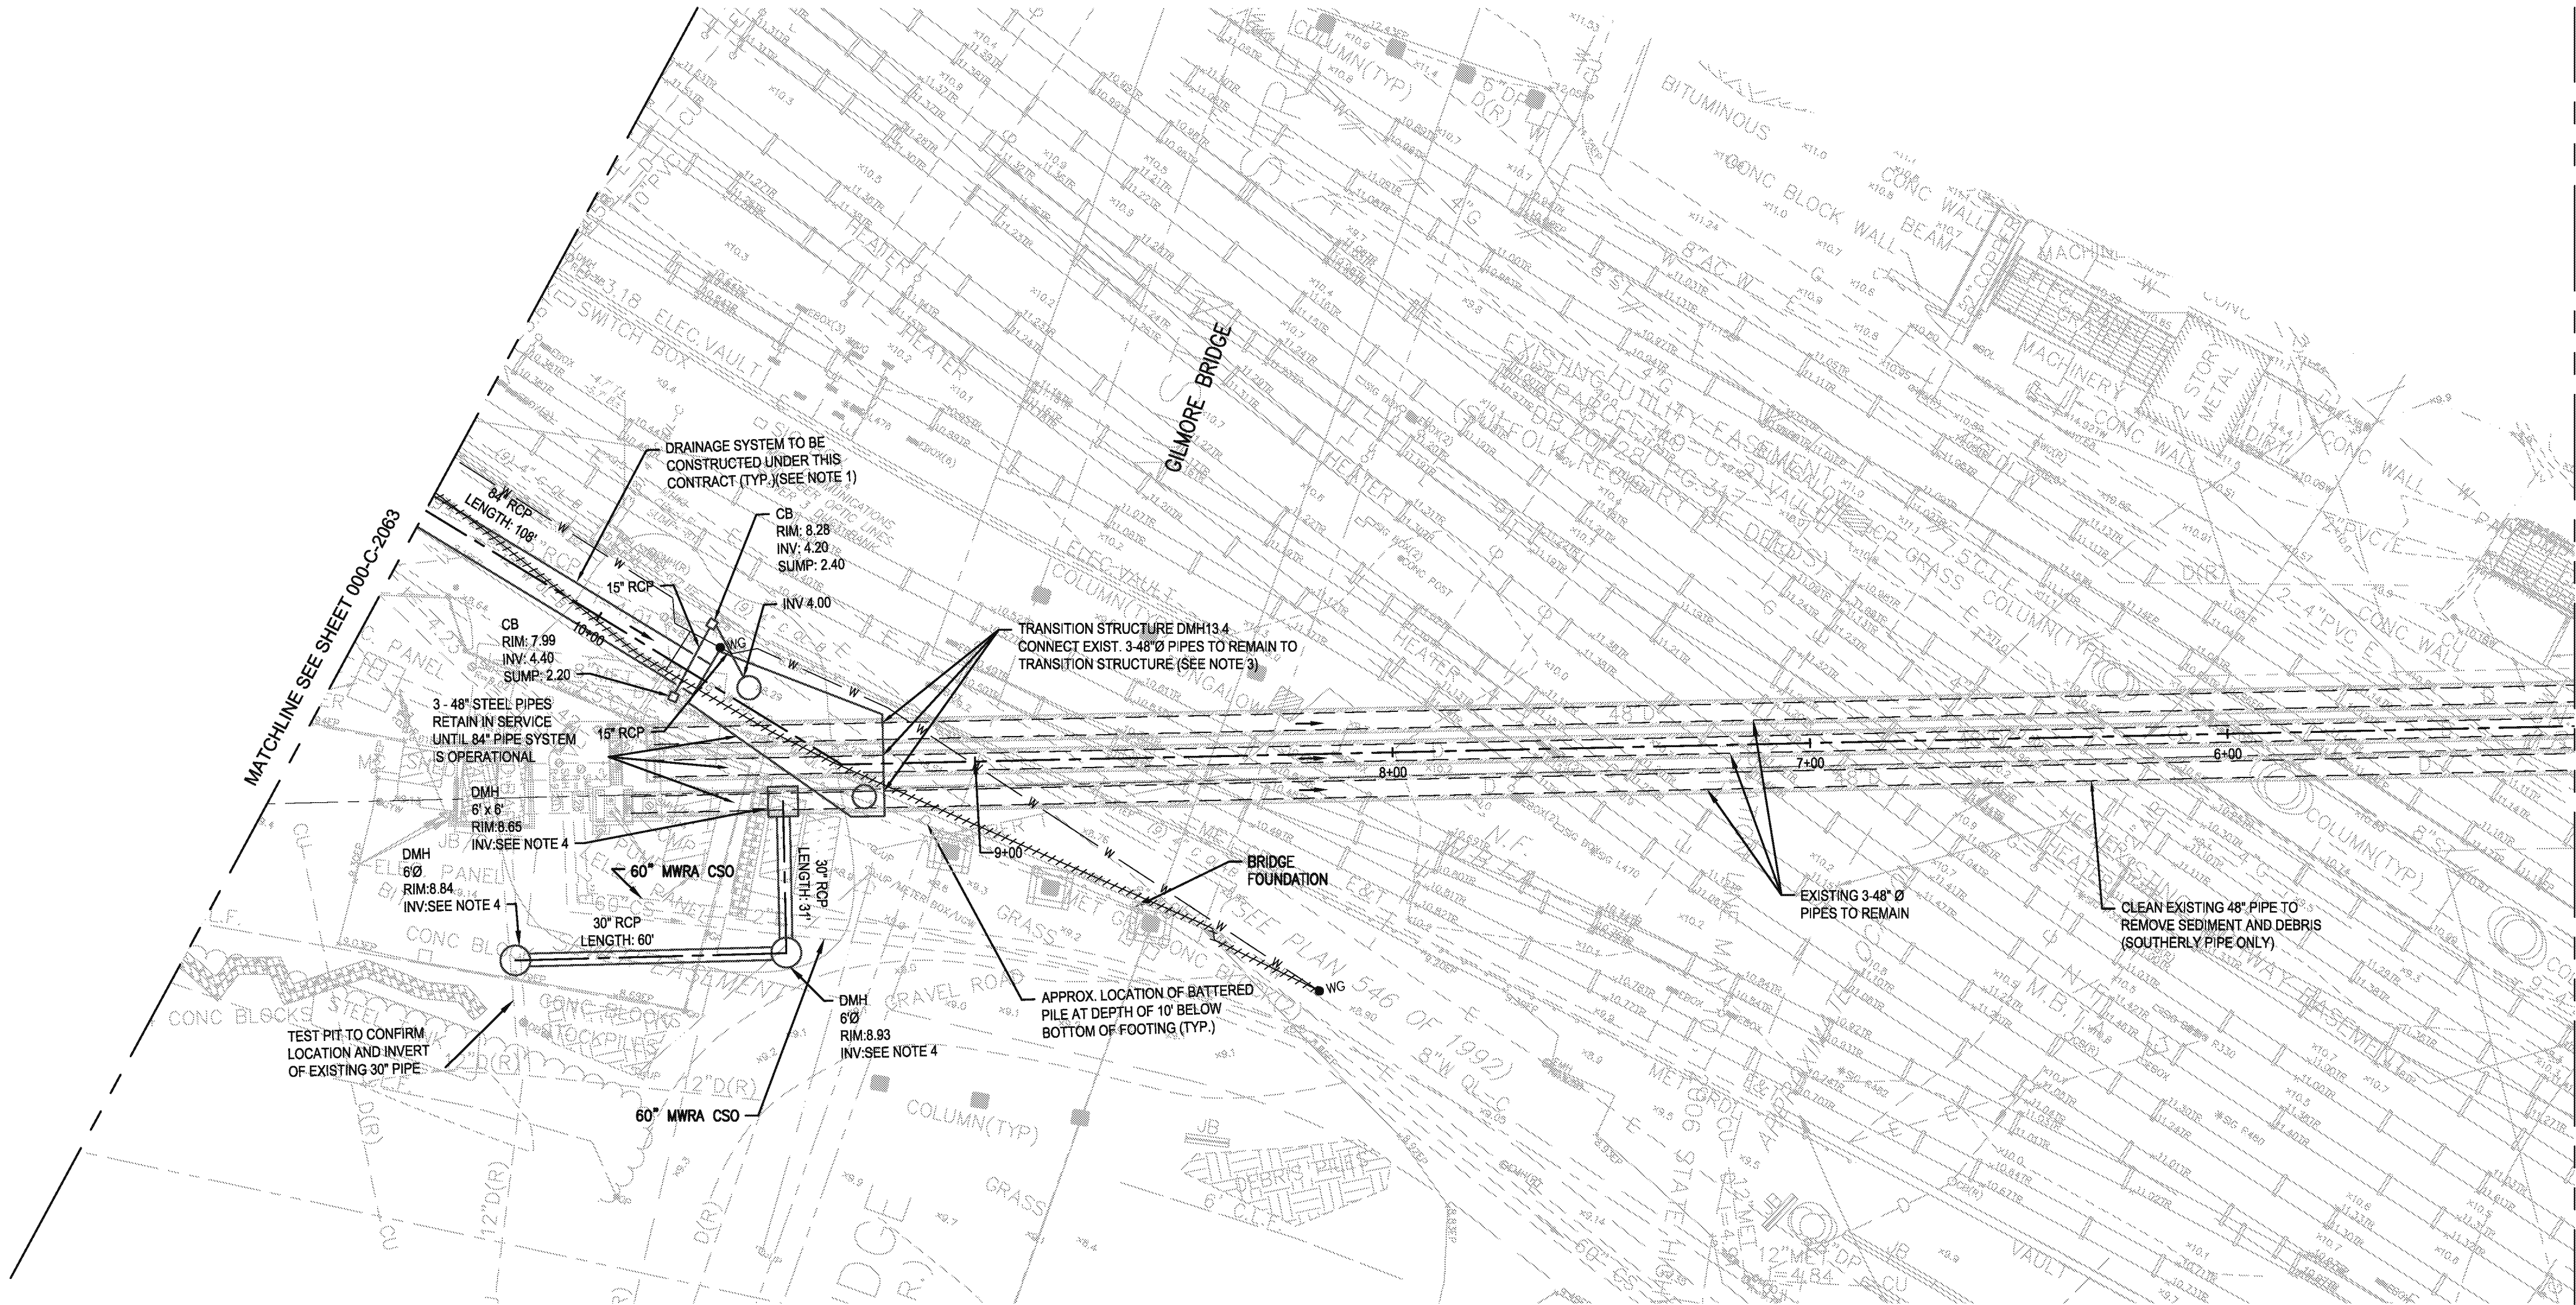


09/11/14 2:48PM BY: GRS/SL/AT  
DRAWING: C:\USERS\GROSS\SL\A\DWG\000-C-2063-IGMP3.DWG [000-C-2063-IGMP3] 09/02/14 6:15PM

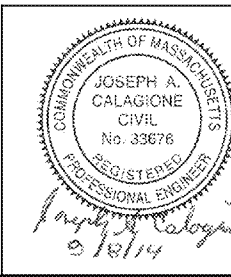

NOTES:

1. WHEN PRINTING IN COLOR, THIS SHEET CONTAINS DRAINAGE SYSTEMS IN RED (PIPES AND MANHOLES) TO INDICATE DRAINAGE WORK CONSTRUCTED UNDER THIS CONTRACT (IGMP-03).
2. SEE THE UTILITY PLANS FOR FURTHER DESCRIPTION OF PROPOSED UTILITIES AND IN WHICH SPECIFIC GLX CONTRACT EACH IS TO BE INSTALLED.
3. FOR DETAILS OF DMH 13.4 SEE DETAILS ON SHEET 000-C-8028.
4. PROFILE SHALL BE ESTABLISHED BY ENGINEER BASED ON INVERTS ESTABLISHED IN THE FIELD BY CONTRACTOR.
5. FOR SPECIAL SUBGRADE PREPARATION AND BACKFILL REQUIREMENTS FOR ALL PIPES AND STRUCTURES ON THIS SHEET, SEE SHEET 000-C-0001.

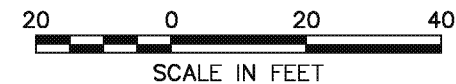

GLX		massDOT	
0		09/12/14	
CONFORMED DOCUMENT SUBMISSION - IGMP-03		BY: CHKD APP:	
ISSUE		DATE	

MASSACHUSETTS BAY TRANSPORTATION AUTHORITY	
GREEN LINE EXTENSION PROJECT MBTA CONTRACT NO. E22CN04 CAMBRIDGE/SOMERVILLE, MASSACHUSETTS	
MEDFORD BRANCH DRAINAGE PLAN MILLERS RIVER DRAINAGE SHEET 2	
AECOM   HNTB	
SCALE: 1"=20'	DRAWN BY: SN
DATE: SEP 12, 2014	DESIGN BY: PWB
CHECK BY: TMC	PLAN NO. 178,655
SHEET: 000-C-2062	ISSUE 0